
PRELIMINARY SP SUBMITTAL: OCTOBER 27, 2021 PRELIMINARY SP RESUBMITTAL: DECEMBER 21, 2021 PRELIMINARY SP RESUBMITTAL: JANUARY 18, 2022 PRELIMINARY SP RESUBMITTAL: FEBRUARY 1, 2022 PRELIMINARY SP CORRECTION SET: FEBRUARY 15, 2022

SITE DATA TABLE			ISTING PROPERTY SUMMARY
ITE ADDRESS	4186 DODSON CHAPEL RD/ 4107 DODSON CHAPEL CT HERMITAGE, TN, 37076		PERTY ADDRESS: 4186 DODSON CHAPEL RD/ 4107 DO
AX MAP	MAP 086 PARCELS 055, 056		HERMITAGE, TN
OVERALL AREA	EXISTING	PROPOSED	AND PARCEL ID: MAP 086, PARCEL 055; 056
TE AREA	± 10.70 AC	± 10.38 AC	FEMA FIRM PANEL: 47037C0286H DATED 04/05/2017
STURBED AREA	N/A	± 9.65 AC	TING ZONING: RS15; SP TING LAND USE: RESIDENTIAL/ DAYCARE-VACANT
EDICATED R.O.W. AREA	N/A	± 0.32 AC	NERAL DEVELOPMENT NOTES
PERVIOUS AREA	± 1.53 AC	± 5.66 AC	LI DEVELOPMENT MITURITURE POLINICADIES OF THE DIAN.
ERVIOUS AREA	± 9.17 AC	± 4.72 AC	LL DEVELOPMENT WITHIN THE BOUNDARIES OF THIS PLAN EETS THE REQUIREMENTS OF ANSI 117.1, 2009 EDITION AND HE FAIR HOUSING ACT.
BUILDING D	DATA	•	S. Justice Department:
SE SE	-	' RESIDENTIAL; IHOMES	tp://www.justice.gov/crt/housinig/fairhousing/about_fairhousingact.l
JLTIFAMILY RESIDENTIAL	159,2	200 SF	HE SUBJECT PROPERTY IS LOCATED IN AREAS DESIGNATED S "ZONE X" (AREAS DETERMINED TO BE OUTSIDE THE 0.2 %
DWNHOME RESIDENTIAL	76,0	32 SF	NNUAL CHANCE FLOODPLAIN) AS NOTED ON THE CURRENT EMA FIRM COMMUNITY PANEL 47037C0286H EFFECTIVE 5/2017.
ESIDENTIAL FAR (MAX. 1.0)	C).51	NY EXCAVATION, FILL, OR DISTURBANCE OF THE EXISTING ROUND ELEVATION MUST BE DONE IN ACCORDANCE WITH
PEN SPACE (PASSIVE)	± 3.	00 AC	TORM WATER MANAGEMENT ORDINANCE NO. 78/840 AND PPROVED BY THE METROPOLITAN DEPARTMENT OF WATER
AX. BUILDING HEIGHT	3 ST	ORIES	ERVICES. ETRO WATER SERVICES SHALL BE PROVIDED SUFFICIENT A
R (MAX. 0.75)	0	.54	NENCUMBERED ACCESS IN ORDER TO MAINTAIN AND REPA TILITIES IN THIS SITE.
NIT DENSITY	19.27 UN	IITS/ACRE	
AX. UNITS	200	UNITS	
1-BR	90 (JNITS	
2-BR	70 L	JNITS	
TOWNHOMES	40 (JNITS	ELIMINARY SP CONDITION
PARKING D	DATA		L SITE DESIGN LAYOUT AND UNIT COUNT ENTITLEMENT AR
		TINGENT ON THE RESULTS OF A FLOOD STUDY TO BE	

EXISTING PROPERTY SOMMARY				
PROPERTY ADDRESS:	4186 DODSON CHAPEL RD/ 4107 DODSON CHAPEL CT HERMITAGE, TN			
MAP AND PARCEL ID:	MAP 086, PARCEL 055; 056			
U.S. FEMA FIRM PANEL:	47037C0286H DATED 04/05/2017			
EXISTING ZONING: EXISTING LAND USE:	RS15; SP RESIDENTIAL/ DAYCARE-VACANT			
GENERAL DEVE	LOPMENT NOTES			
1. ALL DEVELOPMENT WIT	THIN THE BOUNDARIES OF THIS PLAN ENTS OF ANSI 117.1, 2009 EDITION AND			
ALL DEVELOPMENT WITMEETS THE REQUIREM THE FAIR HOUSING ACTUS. Justice Department:	THIN THE BOUNDARIES OF THIS PLAN ENTS OF ANSI 117.1, 2009 EDITION AND			

	0.
	APPROVED BY THE METROPOLITAN DEPARTMENT OF WATER
	SERVICES.
5.	METRO WATER SERVICES SHALL BE PROVIDED SUFFICIENT AND
	UNENCUMBERED ACCESS IN ORDER TO MAINTAIN AND REPAIR

NTITLEMENT ARE COMPLETED PRIOR TO FINAL SITE PLAN APPROVAL. THE FLOOD STUDY WILL DETERMINE THE FLOODWAY, FLOODPLAIN, AND STREAM BUFFER LOCATIONS AS WELL AS AREAS REQUIRING COMPENSATING CUT AND FILL FOR THE SITE.

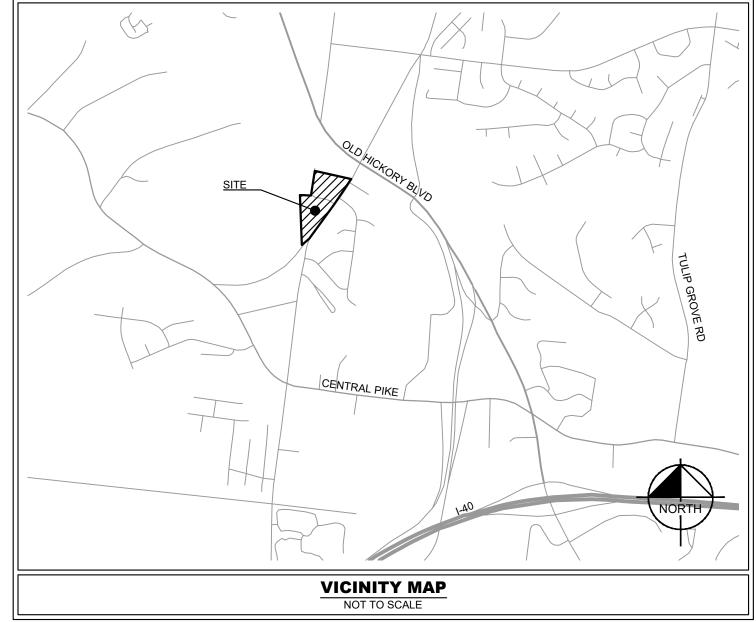

SHEET LIST TABLE				
SHEET NUMBER	SHEET TITLE			
C0-00	COVER			
C1-00	EXISTING CONDITIONS			
C2-00	SITE LAYOUT - OVERALL			
C4-00	GRADING AND DRAINAGE PLAN - OVERALL			
C6-00	UTILITY PLAN - OVERALL			
C8-00	SITE DETAILS			
	3-STORY BUILDING ELEVATIONS			
	TOWNHOME ELEVATIONS			
	TOWNHOME ELEVATIONS			

COUNCIL DISTRICT 14 COUNCIL MEMBER KEVIN RHOTEN CITY OF HERMITAGE DAVIDSON COUNTY, TN

CASE NO.: 2021SP-092-001

PROJECT DESIGN TEAM

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METRO NASHVILLE FIRE MARSHAL

FIRE CHIEF

JOSEPH ALMON

800 SECOND AVE. SOUTH

NASHVILLE, TN 37210

PHONE: (615) 862-6242

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NDOT

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STORMWATER

TDOT TENNESSEE DEPARTMENT OF TRANSPORTATION PHIL TRAMMELL REGION 3 TRAFFIC ENGINEER 660 CENTENNIAL BLVD NASHVILLE, TN 37243

MATTHEW CHARLES 800 SECOND AVE. SOUTH

WATER

CIVIL ENGINEER

PHONE: (615) 862-4600 NATURAL GAS PIEDMONT NATURAL GAS

CRAIG OWEN 83 CENTURY BOULEVARD NASHVILLE, TENNESSEE 37214 PHONE: 615-872-8034

METRO NASHVILLE PLANNING **DUSTIN SHANE**

CONTACT: JUDY L. JOHNSON

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PLANNING

ELECTRIC

NASHVILLE ELECTRIC SERVICE COMCAST LARRY KELLY 1214 CHURCH STREET NASHVILLE, TN 37246 PHONE: (615) 747-3688

URBAN FORESTER METRO NASHVILLE

STEPHAN KIVETT 800 SECOND AVE. SOUTH NASHVILLE, TN 37210 PHONE: (615) 862-6488

PLANS PREPARED BY Kimley» Horn

10 Lea Avenue, Suite 400, Nashville, TN 37210 Main: 615.564.2701 | www.kimley-horn.com © 2022 Kimley-Horn and Associates, Inc.

	PLAN REVISIONS				
	REVISION NO.	DATE	REMARKS		
ENGINEER'S SEAL					
DRAFT					
PRELIMINARY PLANS					
FOR REVIEW ONLY	FILE NUMBER 012877016	SHEET NUMBER CO-00	TOTAL SHEETS		



REQUIRED SPACES PROVIDED SPACES

310

310

800 SECOND AVE. SOUTH NASHVILLE, TN 37210 PHONE: (615) 862-4600

NASHVILLE, TN 37210

PHONE: (615) 350-4300

METRO WATER SERVICES METRO WATER SERVICES GEORGE REAGAN

800 SECOND AVE. SOUTH NASHVILLE, TN 37210 PHONE: (615) 862-4572

SANITARY SEWER

TELEPHONE AT&T


LOGAN EAKES 6405 CENTENNIAL BOULEVARD NASHVILLE, TENNESSEE 37209 PHONE: 615-350-9375


CABLE

KEVIN VIA 660 MAINSTREAM DRIVE NASHVILLE, TENNESSEE 37228 PHONE: 615-405-5563





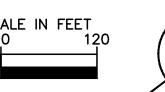

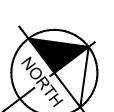

EXISTING CONDITIONS

KIMLEY-HORN PROJECT NO. 012877016


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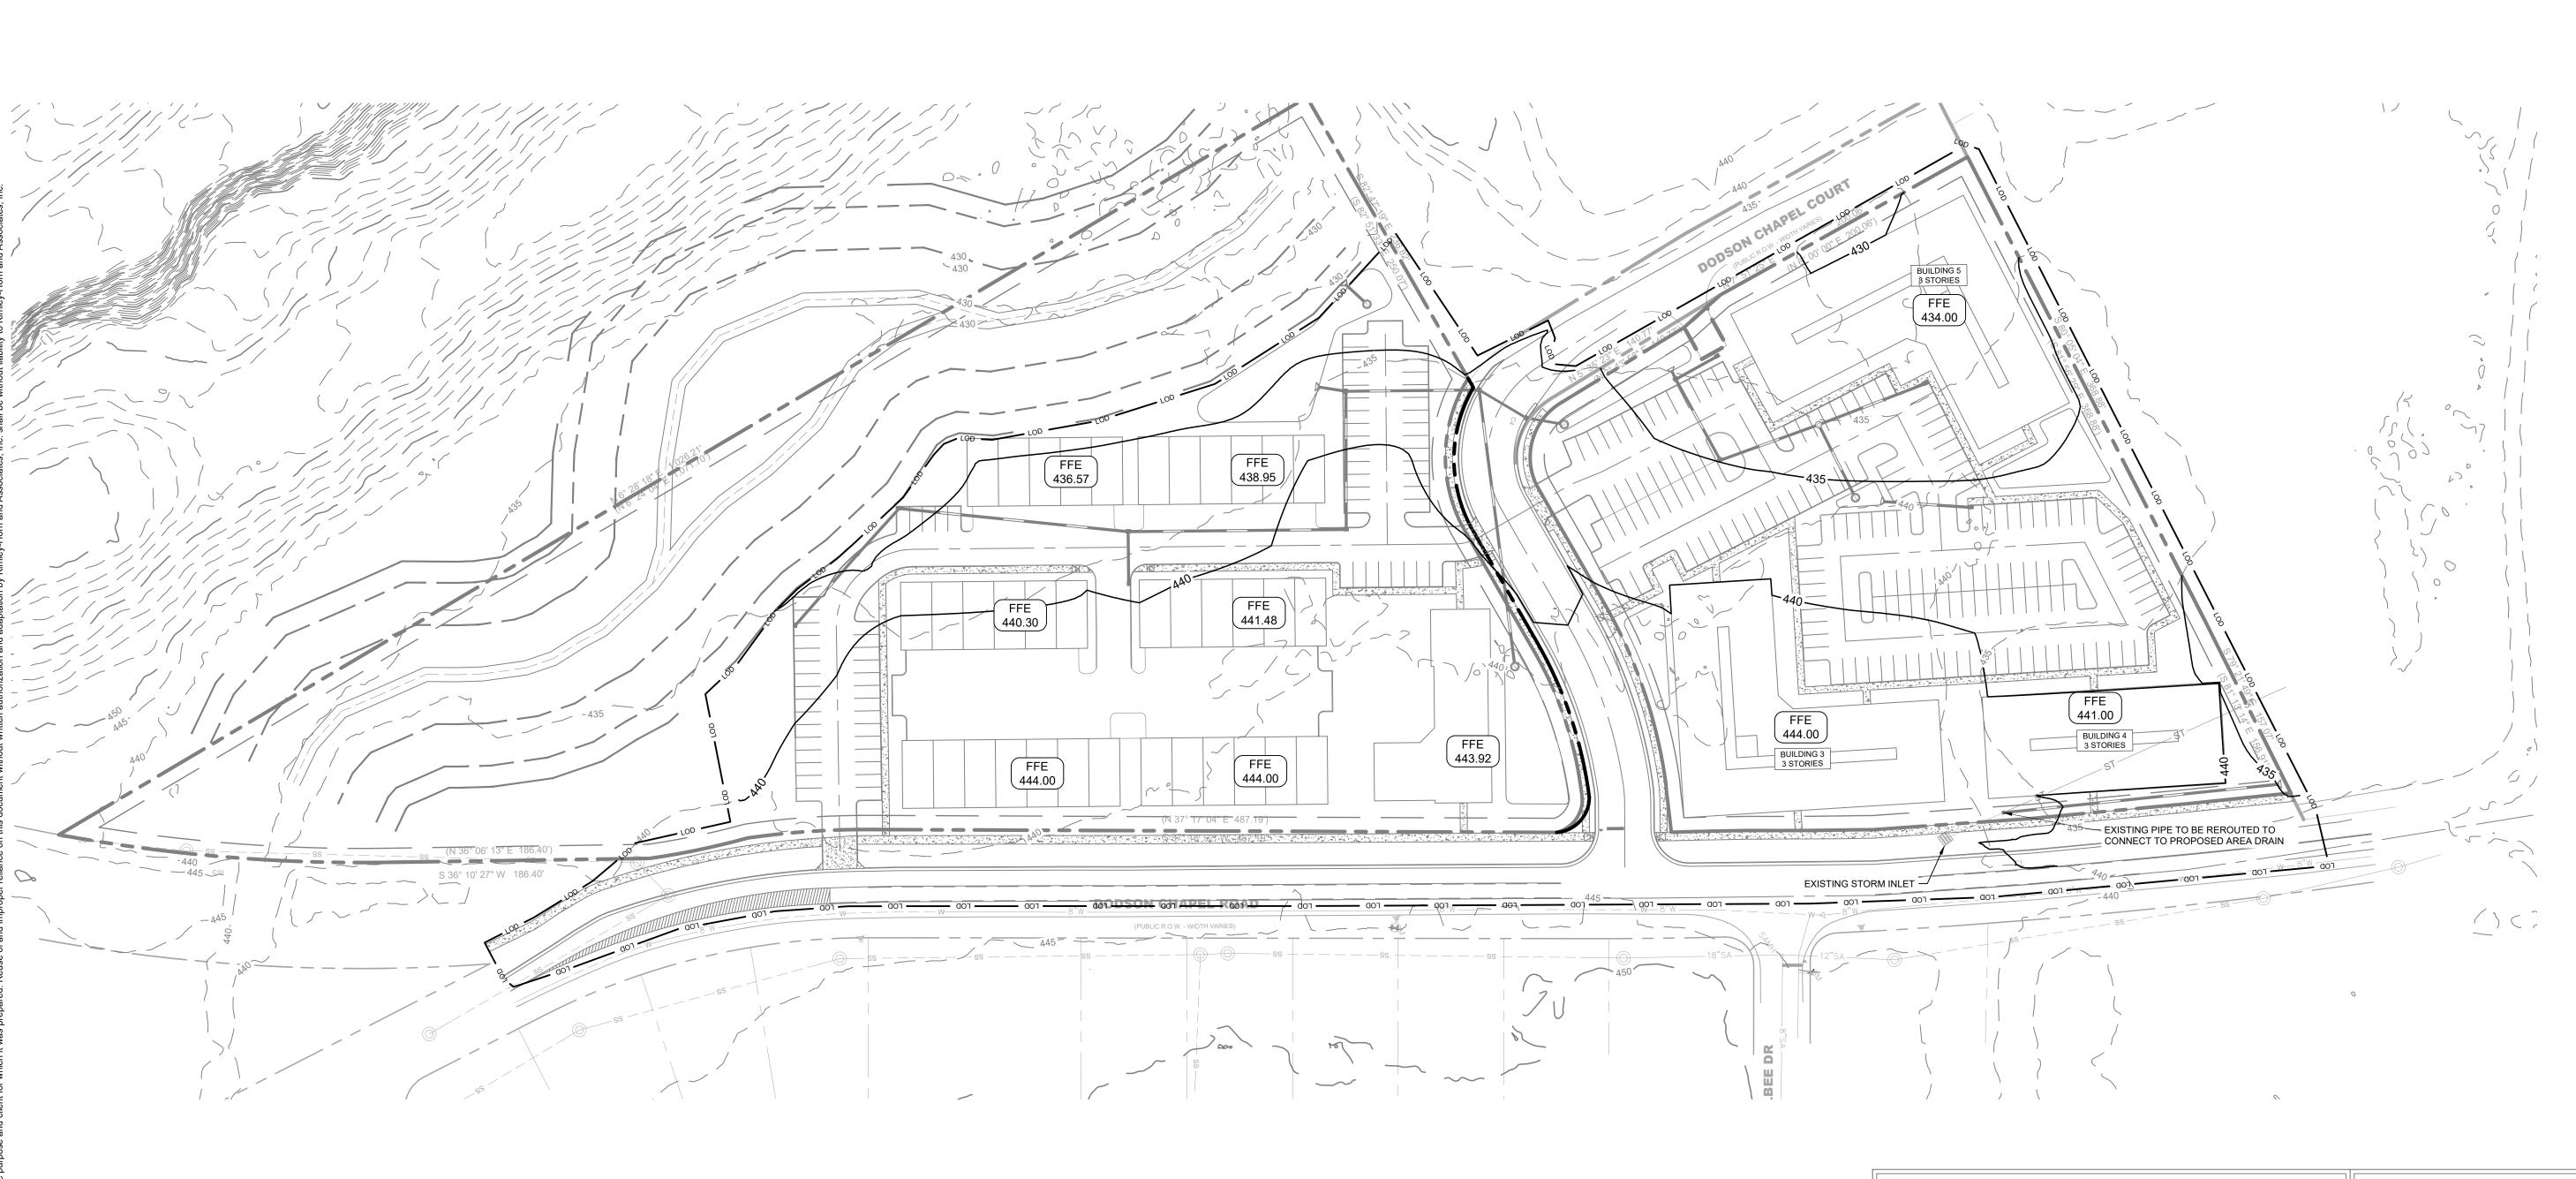
PRELIMINARY PLANS

FOR REVIEW ONLY

SHEET NUMBER C1-00



C2-00

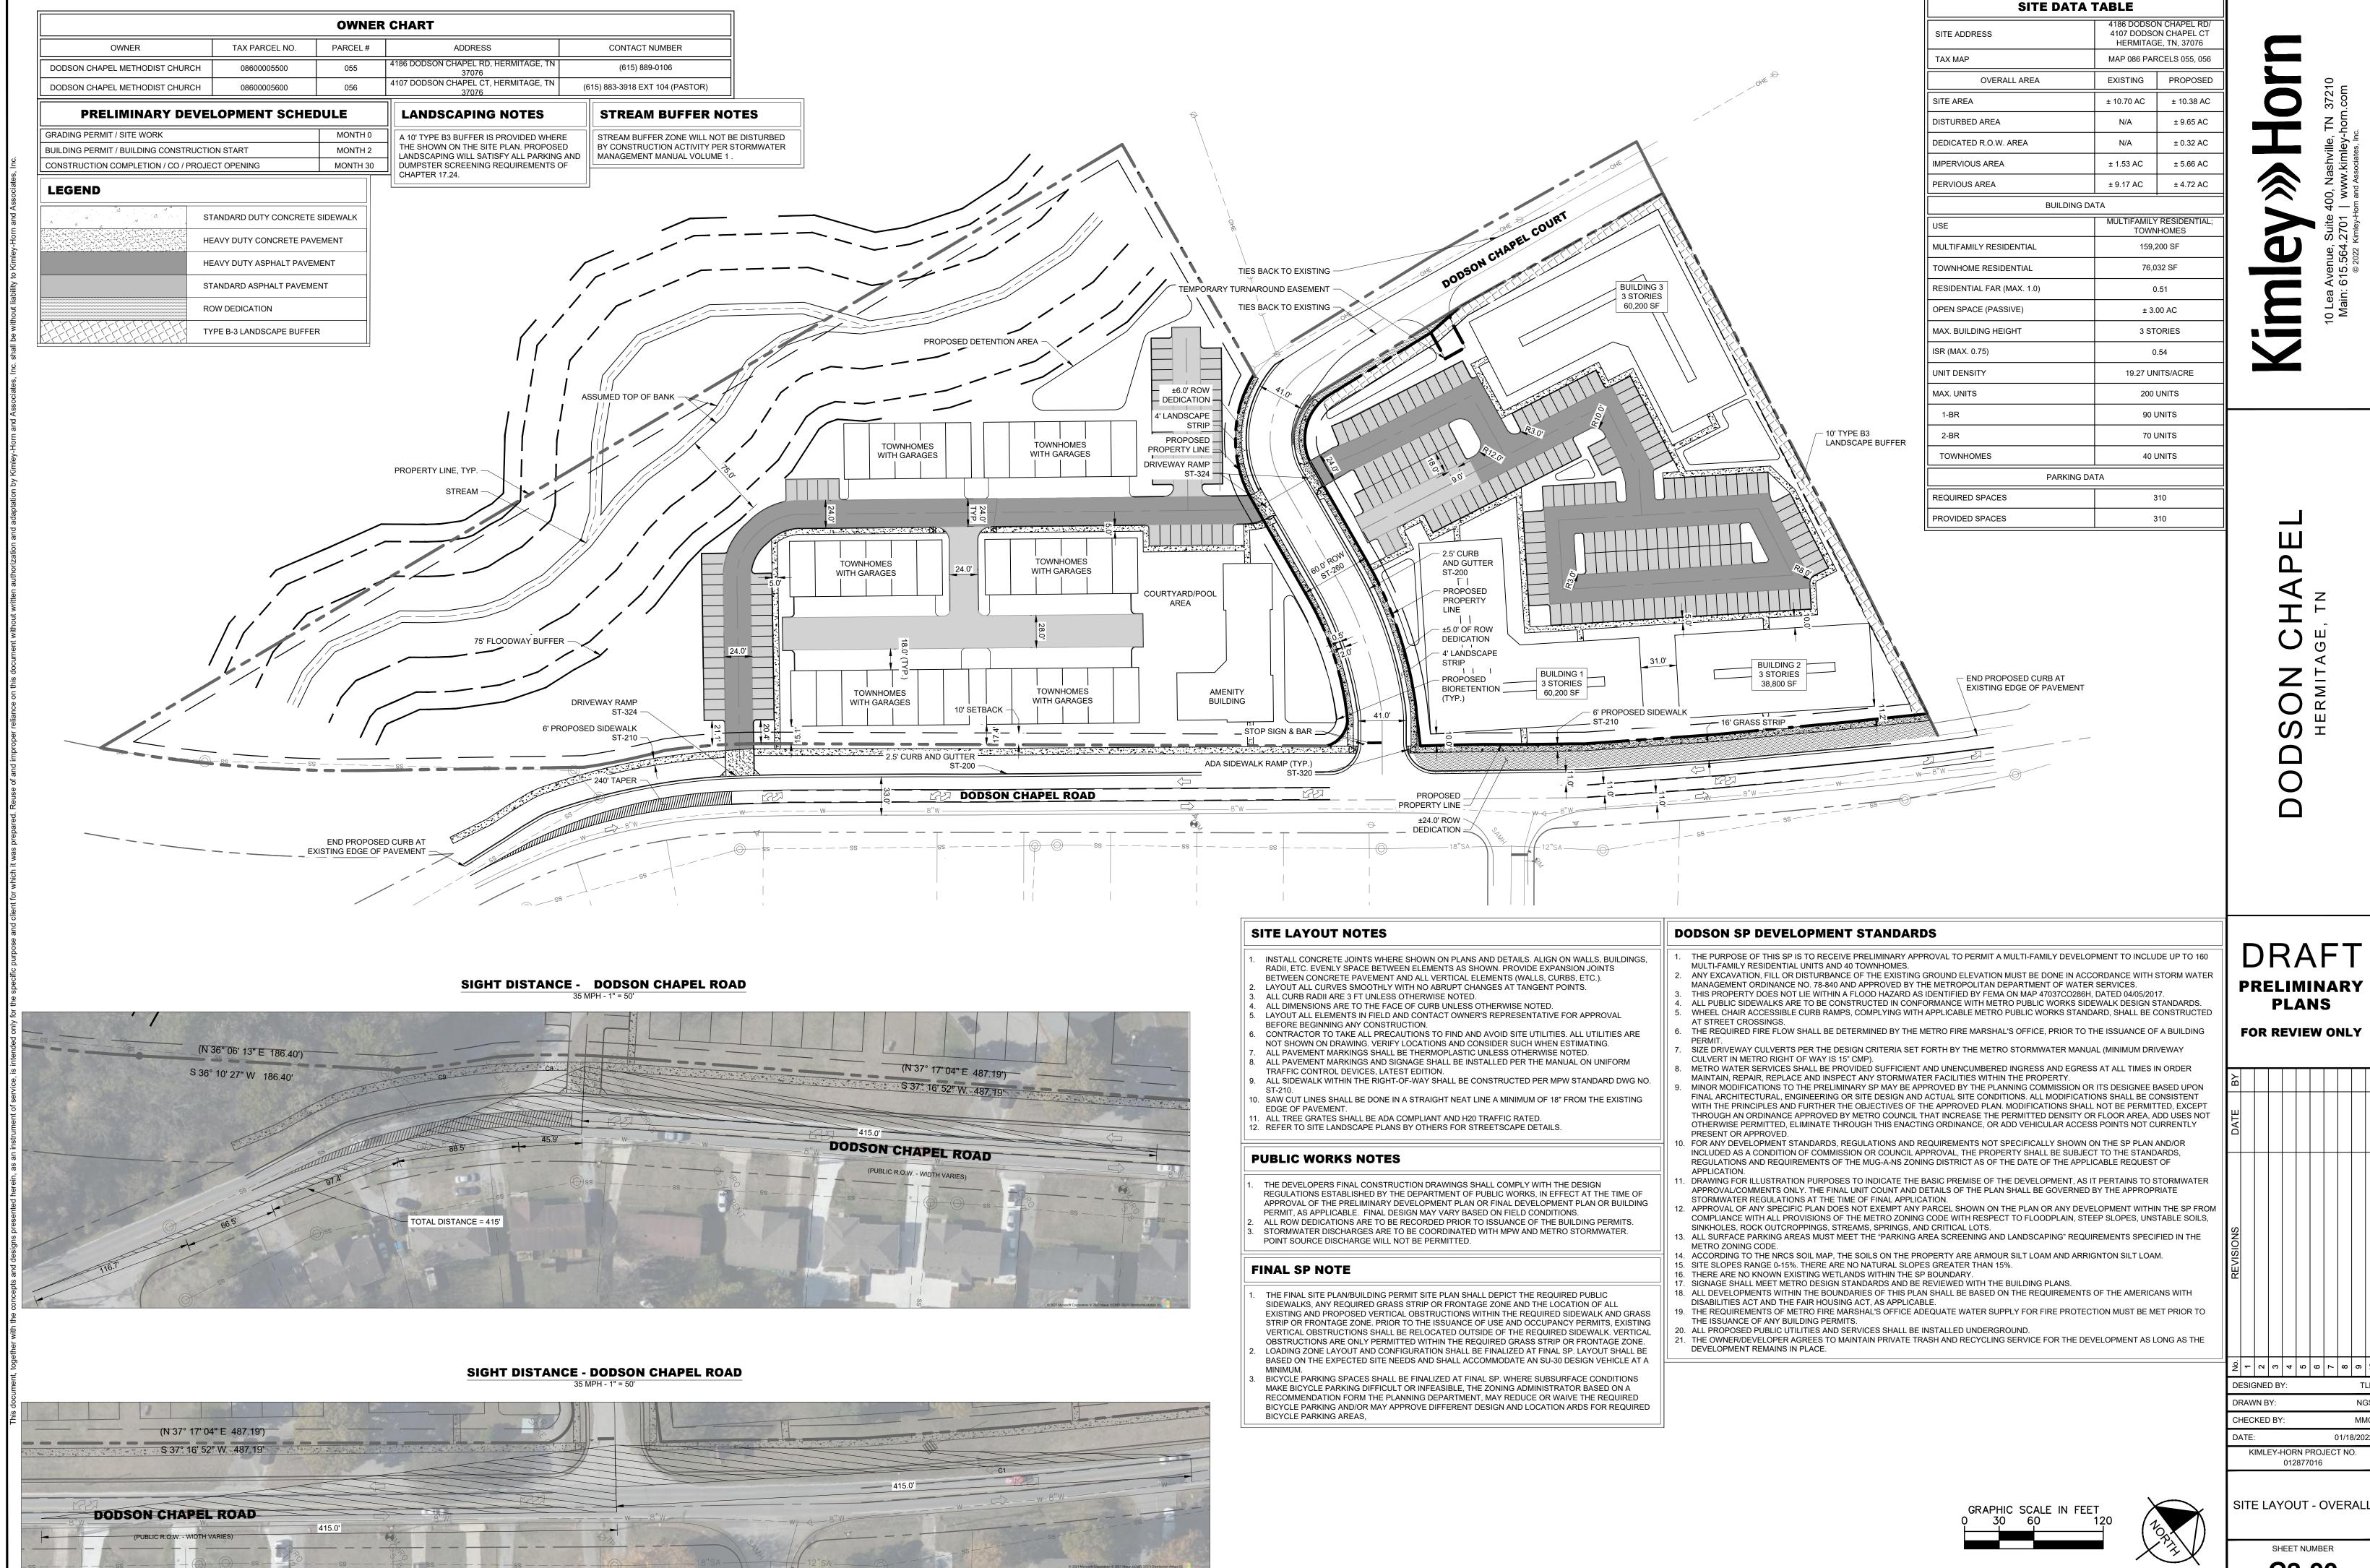

GRADING NOTES

- 1. CONTRACTOR RESPONSIBLE FOR VERIFYING LOCATION, SIZE, AND ELEVATIONS OF EXISTING UTILITIES AT CONNECTION POINTS PRIOR TO GRADING OR INSTALLATION OF ANY PROPOSED UTILITIES. CONTRACTOR TO IMMEDIATELY NOTIFY OWNER'S REPRESENTATIVE IF DISCREPANCIES ARE FOUND. 2. AREAS FOR CONSTRUCTION THAT REQUIRE DE-WATERING FOR EXCAVATION WILL BE
- DONE AT NO ADDITIONAL COST TO THE OWNER AND IN ACCORDANCE WITH SECTION 4.1.4 OF THE TENNESSEE GENERAL NPDES PERMIT FOR DISCHARGES OF STORMWATER ASSOCIATED WITH CONSTRUCTION ACTIVITIES.
- 3. ADDITIONAL EROSION CONTROL DEVICES TO BE USED AS REQUIRED BY LOCAL INSPECTOR. 4. DISTURBED AREAS LEFT IDLE FOR FIVE DAYS, AND NOT TO FINAL GRADE, WILL BE ESTABLISHED TO TEMPORARY VEGETATION. MULCH, TEMPORARY VEGETATION OR PERMANENT VEGETATION SHALL BE COMPLETED ON ALL EXPOSED AREAS WITHIN 14 DAYS
- AFTER DISTURBANCE. ALL AREAS TO FINAL GRADE WILL BE ESTABLISHED TO PERMANENT VEGETATION UPON COMPLETION. 5. WHEN HAND PLANTING, MULCH (HAY OR STRAW) SHOULD BE UNIFORMLY SPREAD OVER SEEDED AREA WITHIN 24 HOURS OF SEEDING. IF UNABLE TO ACCOMPLISH, MULCH SHALL BE USED AS A TEMPORARY COVER. CONCENTRATED FLOW AREAS AND ALL SLOPES STEEPER THAN 2.5:1 AND WITH A HEIGHT OF TEN FEET OR GREATER (DOES NOT APPLY TO RETAINING WALLS), AND CUTS AND FILLS WITHIN BUFFERS, SHALL BE STABILIZED WITH
- THE APPROPRIATE EROSION CONTROL MATTING OR BLANKETS. 6. THE GRADING PERMIT MUST BE DISPLAYED ON SITE AT ALL TIMES DURING CONSTRUCTION AND IN PLAIN VIEW FROM A PUBLIC ROAD OR STREET. EROSION AND SEDIMENT CONTROL DEVICES MUST BE DISPLAYED AND INSPECTED PRIOR TO ANY GRADING ON SITE. THE CONTRACTOR MUST CALL FOR AN INSPECTION TO OBTAIN
- A PERMIT TO GRADE. PLEASE CALL WITH ENOUGH LEAD-TIME FOR AN INSPECTION TO MEET YOUR SCHEDULE. 8. SEDIMENT/EROSION CONTROL DEVICES MUST BE INSPECTED ACCORDING TO LOCAL AND STATE REQUIREMENTS AND AS STIPULATED IN THE STORMWATER POLLUTION PREVENTION PLAN. EACH DEVICE IS TO BE MAINTAINED OR REPLACED IF SEDIMENT ACCUMULATION HAS REACHED ONE HALF THE CAPACITY OF THE DEVICE. ADDITIONAL
- 9. THE ESCAPE OF SEDIMENT FROM THE SITE SHALL BE PREVENTED BY THE INSTALLATION OF EROSION AND SEDIMENT CONTROL MEASURES AND PRACTICES PRIOR TO, OR CONCURRENT WITH, LAND-DISTURBING ACTIVITIES.

DEVICES MAY BE NECESSARY AS THE PROJECT PROGRESSES AND NEW CHANNELS HAVE

- 10. EROSION CONTROL MEASURES WILL BE MAINTAINED AT ALL TIMES. IF FULL IMPLEMENTATION OF THE PLAN DOES NOT PROVIDE FOR EFFECTIVE EROSION CONTROL, ADDITIONAL EROSION CONTROL AND SEDIMENT CONTROL MEASURES SHALL BE IMPLEMENTED TO CONTROL OR TREAT THE SEDIMENT SOURCE.
- 11. CONTRACTOR SHALL REVIEW SITE GEOTECHNICAL REPORT BEFORE COMMENCING GRADING OPERATIONS. 12. SEED ALL DISTURBED AREAS UNLESS OTHERWISE NOTED AS PART OF THIS CONTRACT.
- REFER TO LANDSCAPING PLANS FOR AREAS TO RECEIVE SOD. 13. INSTALL SOD OR RIPRAP IN SWALES AS INDICATED ON GRADING PLANS AND EROSION
- CONTROL PLANS 14. TOPSOIL ON SITE TO BE STRIPPED AND STOCKPILED FOR REUSE IN LAWN AREAS. 15. ADEQUATE DRAINAGE, EROSION AND SEDIMENT CONTROL MEASURES, BEST MANAGEMENT PRACTICES, AND/OR OTHER WATER QUALITY MANAGEMENT FACILITIES SHALL BE PROVIDED AND MAINTAINED AT ALL TIMES DURING CONSTRUCTION. DAMAGES TO
- ADJACENT PROPERTY AND/OR THE CONSTRUCTION SITE CAUSED BY THE CONTRACTOR'S OR PROPERTY OWNER'S FAILURE TO PROVIDE AND MAINTAIN ADEQUATE DRAINAGE AND EROSION/SEDIMENT CONTROL FOR THE CONSTRUCTION AREA SHALL BE THE RESPONSIBILITY OF THE PROPERTY OWNER AND/OR CONTRACTOR. 16. UNDERGROUND UTILITIES HAVE NOT BEEN VERIFIED BY THE OWNER, DESIGNER, OR THEIR
- REPRESENTATIVES. BEFORE YOU DIG CALL ONE CALL--811 OR 1-800-752-6007 17. THE CONTRACTOR SHALL DETERMINE THE EXACT LOCATION OF ALL EXISTING UTILITIES BEFORE COMMENCING WORK AND AGREES TO BE RESPONSIBLE FOR ANY AND ALL DAMAGES WHICH MIGHT RESULT FROM THE CONTRACTOR'S FAILURE TO EXACTLY LOCATE AND PRESERVE ANY UNDERGROUND UTILITIES TO REMAIN.

METRO STORMWATER NOTES

THIS LOT DOES NOT LIE IN AN AREA DESIGNATED AS A SPECIAL FLOOD HAZARD AREA ACCORDING TO FEDERAL EMERGENCY MANAGEMENT AGENCY FLOOD INSURANCE RATE MAP 47037C0286H, EFFECTIVE 04/05/2017.

CONSTRUCTION SCHEDULE:

- 1. PRE-CONSTRUCTION MEETING 2. INSTALLATION OF EROSION CONTROL MEASURES 3. EROSION INSPECTION BY EPSC AND METRO 4. ISSUANCE OF GRADING PERMIT
- CONSTRUCTION SHALL BE COMPLETED WITHIN 12 MONTHS OF THE GRADING PERMIT BEING ISSUED. IF CONSTRUCTION IS NOT COMPLETE IN THAT AMOUNT OF TIME, IT IS THE RESPONSIBILITY

CONSTRUCTION

GRADING PERMIT. TDEC NOTICE OF COVERAGE NOTE: THIS PROJECT DOES DISTURB MORE THAN 1 ACRE AND IS REQUIRED TO APPLY FOR A NOTICE OF COVERAGE UNDER THE

OF THE CONTRACTOR TO APPLY FOR AN EXTENSION OF THE

TENNESSEE GENERAL CONSTRUCTION PERMIT FROM TDEC. THE TOTAL DISTURBED AREA IS ±9.65 ACRES.

GRADING PLAN LEGEND

SPOT ELEVATION 476.17 HP HIGH POINT

TC TOP OF CURB BC BOTTOM OF CURB / GUTTER LINE
TW TOP OF WALL BW BOTTOM OF EXPOSED WALL RIM TOP OF GRATE / COVER

FINISH FLOOR ELEVATION

EXISTING CONTOUR PROPOSED CONTOUR ---500

S - 2 8 4 5 9 7 8 6 5 DESIGNED BY: DRAWN BY: CHECKED BY: 01/18/2022 KIMLEY-HORN PROJECT NO.


> GRADING AND DRAINAGE PLAN -OVERALL

012877016

SHEET NUMBER C4-00

Drawing name: K:\NSH_LDEV\012877016 - Greystar Dodson Chapel\4-CADD\PlanSheets\C4-00 GRADING AND DRAINAGE PLAN - OVERALL.dwg C4-00 GRADING AND DRAINAGE PLAN - OVERALL Feb 15, 2022 10:07am by: Megan.Barrett

DRAFT **PRELIMINARY PLANS** FOR REVIEW ONLY

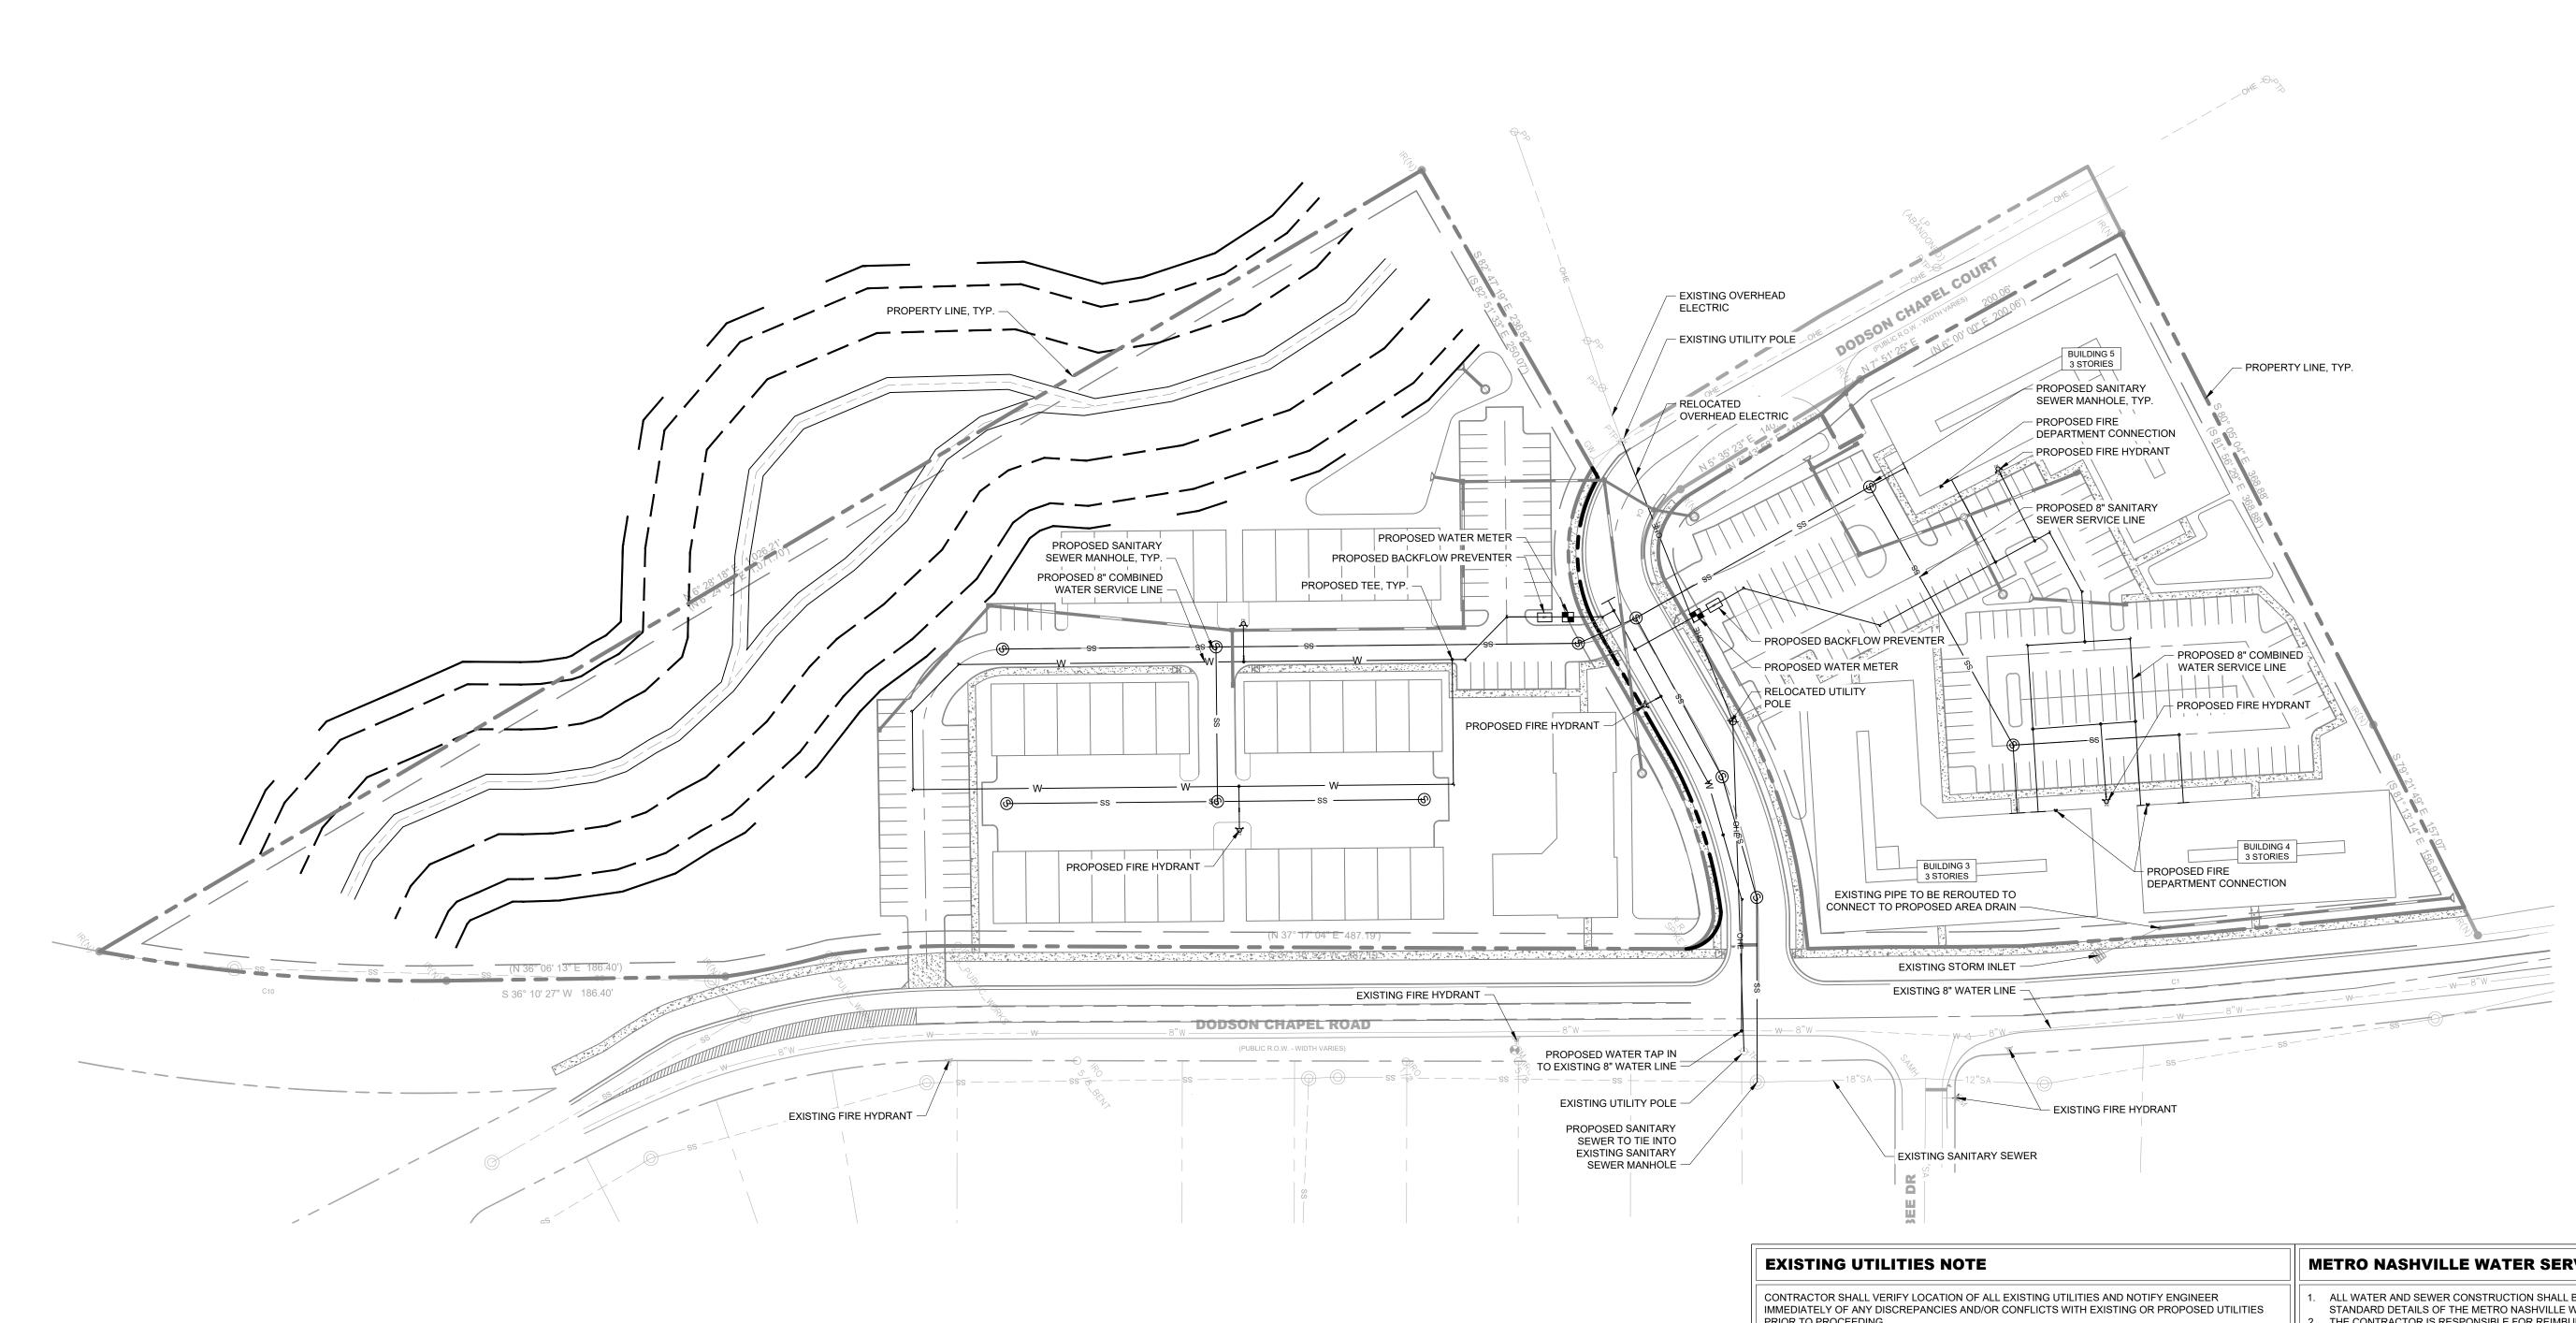

PRIOR TO PROCEEDING.

VALVE NOTE

ALL VALVES SHALL BE INSTALLED IN METRO NASHVILLE WATER SERVICES APPROVED VALVE BOX AND COVER. COVER TO BE MARKED WITH "WATER".

UTILITY NOTES

- CONTRACTOR RESPONSIBLE FOR VERIFYING EXISTING ELEVATIONS COMPARED TO THOSE SHOWN ON PLAN PRIOR TO GRADING. NOTIFY OWNER'S REPRESENTATIVE IF DISCREPANCIES ARE
- AREAS FOR CONSTRUCTION THAT REQUIRE DE-WATERING FOR EXCAVATION WILL BE DONE AT NO ADDITIONAL COST TO THE OWNER.
- ALL WATER AND SEWER MATERIALS AND CONSTRUCTION SHALL BE IN COMPLIANCE WITH METRO NASHVILLE WATER SERVICES' STANDARD SPECIFICATIONS. MAINTAIN MINIMUM 10 FEET HORIZONTAL SEPARATION BETWEEN WATER & SANITARY SEWER OR 18" VERTICAL SEPARATION AT CROSSING LOCATIONS.
- REFER TO METRO NASHVILLE WATER SERVICES STANDARD SPECIFICATIONS FOR PIPE BEDDING REQUIREMENTS.
- ALL WATER VALVES TO BE LOCATED OUTSIDE OF PAVED AREAS WHERE POSSIBLE. THE CONTRACTOR SHALL PROVIDE A COMPLETE SET OF AS-BUILT DRAWINGS OF WATER &
- SANITARY SEWER CONSTRUCTION PRIOR TO THE ACCEPTANCE OF THE PUBLIC UTILITIES. CONTRACTOR RESPONSIBLE FOR DISCONNECTING EXISTING WATER SERVICE LINES AT THE
- PUBLIC MAIN PER METRO WATER SERVICES STANDARDS. PAVEMENT REPAIR SHALL BE DONE IN
- ACCORDANCE TO METRO PUBLIC WORKS STANDARD. ALL EXISTING UTILITIES SHALL BE CUT AND CAPPED AT MAIN.

METRO NASHVILLE WATER SERVICES STANDARD NOTES

- ALL WATER AND SEWER CONSTRUCTION SHALL BE IN ACCORDANCE WITH SPECIFICATIONS AND STANDARD DETAILS OF THE METRO NASHVILLE WATER SERVICES. THE CONTRACTOR IS RESPONSIBLE FOR REIMBURSING THE METRO NASHVILLE WATER
- SERVICES THE COST OF INSPECTION. THE CONTRACTOR IS TO PROVIDE AND MAINTAIN THE CONSTRUCTION IDENTIFICATION SIGN FOR
- PRIVATE DEVELOPMENT APPROVED. AFTER COMPLETION OF THE SANITARY SEWER, THE DEVELOPER IS RESPONSIBLE FOR THE
- COORDINATED WITH THE METRO NASHVILLE WATER SERVICES INSPECTION SECTION. ALL COSTS WILL BE BORNE BY THE DEVELOPER.


TELEVISING OF THE LINES PRIOR TO FINAL ACCEPTANCE. THE VIDEOTAPING MUST BE

- ALL CONNECTIONS TO EXISTING MANHOLES SHALL BE BY CORING AND RESILIENT CONNECTOR
- REDUCED PRESSURE BACKFLOW PREVENTION DEVICES (RPBP) OR DUAL CHECK VALVE WILL BE REQUIRED ON ALL TEST AND FILL LINES (JUMPER) NEEDED FOR WATER MAIN CONSTRUCTION
- AND MUST BE APPROVED BY THE METRO NASHVILLE WATER SERVICES. ALL WATER METERS SHALL BE A MINIMUM OF 24" NOT TO EXCEED A MAXIMUM OF 28" BELOW
- FINISHED GRADE. UPON COMPLETION OF CONSTRUCTION OF WATER AND/OR SEWER, THE ENGINEER SHALL PROVIDE THE DEPARTMENT WITH A COMPLETE SET OF AS-BUILT PLANS ON MOIST ERASABLE
- MYLARS IN REVERSE AND IN DIGITAL (*.DWG) FORMAT. SEWER PLANS SHALL BE SEALED BY A LICENSED PROFESSIONAL ENGINEER OR A REGISTERED LAND SURVEYOR AND SHALL INCLUDE ACTUAL FIELD ANGLES BETWEEN LINES, ALL ACTUAL SERVICE LINES AND TEE LOCATIONS, THE DISTANCE OF THE END OF THE SERVICE LINE TO PROPERTY CORNERS AND LINES AND/OR STATION AND OFFSET FROM SEWER CENTERLINE TO END OF SERVICE LINE, THE DEPTH TO THE TOP OF THE END OF THE SERVICE LINE, AND SHALL REFLECT ALL ALIGNMENT AND GRADE CHANGES. WATER LINE PLANS SHALL BE SEALED BY A LICENSED PROFESSIONAL ENGINEER OR A REGISTERED LAND SURVEYOR AND SHALL INCLUDE OFFSET DISTANCE FROM THE ROADWAY CENTERLINE, OR PROPERTY LINE RIGHT OF WAY, LINE DEPTH, LOCATIONS OF HYDRANTS, VALVES, REDUCERS, TEES AND PRESSURE REDUCING DEVICES WHERE APPLICABLE. ALL
- WATER MAINS INTO THE PUBLIC SYSTEM AND ANY CONNECTIONS BEING MADE. PRESSURE REGULATING DEVICES WILL BE REQUIRED ON THE CUSTOMER SIDE OF THE METER WHEN PRESSURES EXCEED 100 PSI.

DRAWINGS MUST BE COMPLETED AND SUBMITTED PRIOR TO ACCEPTANCE OF THE SEWERS OR

-). PRESSURE REGULATING DEVICES WILL BE REQUIRED ON THE STREET SIDE OF THE METER WHEN PRESSURES EXCEED 150 PSI. 1. ALL WATER MAINS MUST BE LOCATED WITHIN THE PAVED AREA INCLUDING ALL BLOW-OFF
- 12. ALL WATER AND/OR SEWER SERVICES, ALONG WITH APPURTENANCES, SHALL BE INSTALLED IN ACCORDANCE WITH SPECIFICATIONS AND STANDARD DETAILS OF THE METRO NASHVILLE WATER SERVICES.
- 13. VERTICAL DOUBLE CHECK VALVE ASSEMBLIES, THAT ARE LOCATED IN INTERIOR ROOMS, CAN
- ONLY BE USED FOR FIRE SERVICES. 14. IRRIGATION LINE SHALL BE COPPER FROM THE METER TO THE BACKFLOW PREVENTER.
- 15. THE MINIMUM FEES OUTLINED IN THE CAPACITY LETTER MUST BE PAID BEFORE COMMERCIAL CONSTRUCTION PLANS CAN BE REVIEWED.
- 16. ALL SEWER SERVICES SHALL BE 6 INCHES IN DIAMETER, FROM CONNECTION AT THE MAIN UNTIL THE FIRST CLEAN OUT ASSEMBLY, UNLESS OTHERWISE NOTED.
- 7. BACKFLOW DEVICE TO REMAIN ACCESSIBLE AT ALL TIMES. 18. PLAN SIZE SHALL BE 24" X 36", AND SHALL SHOW CONTOURS AROUND METER BOXES.



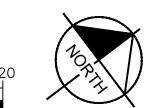

SHEET NUMBER **C6-00**

KIMLEY-HORN PROJECT NO.

012877016

UTILITY PLAN -OVERALL

DESIGNED BY:

DRAWN BY:


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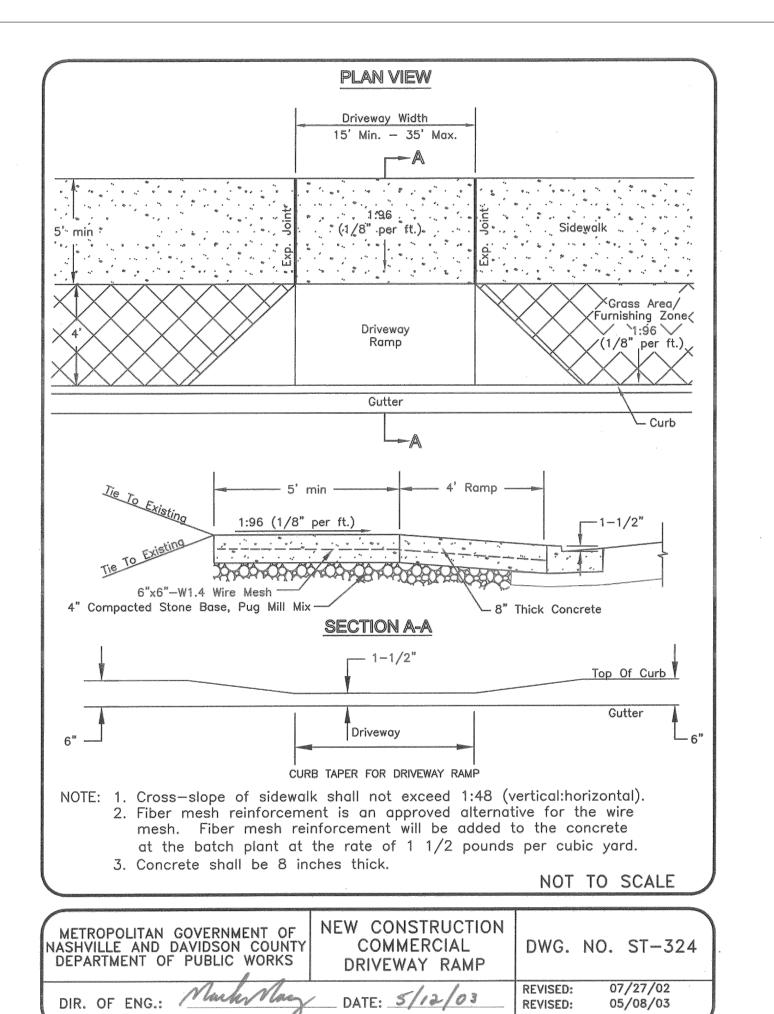
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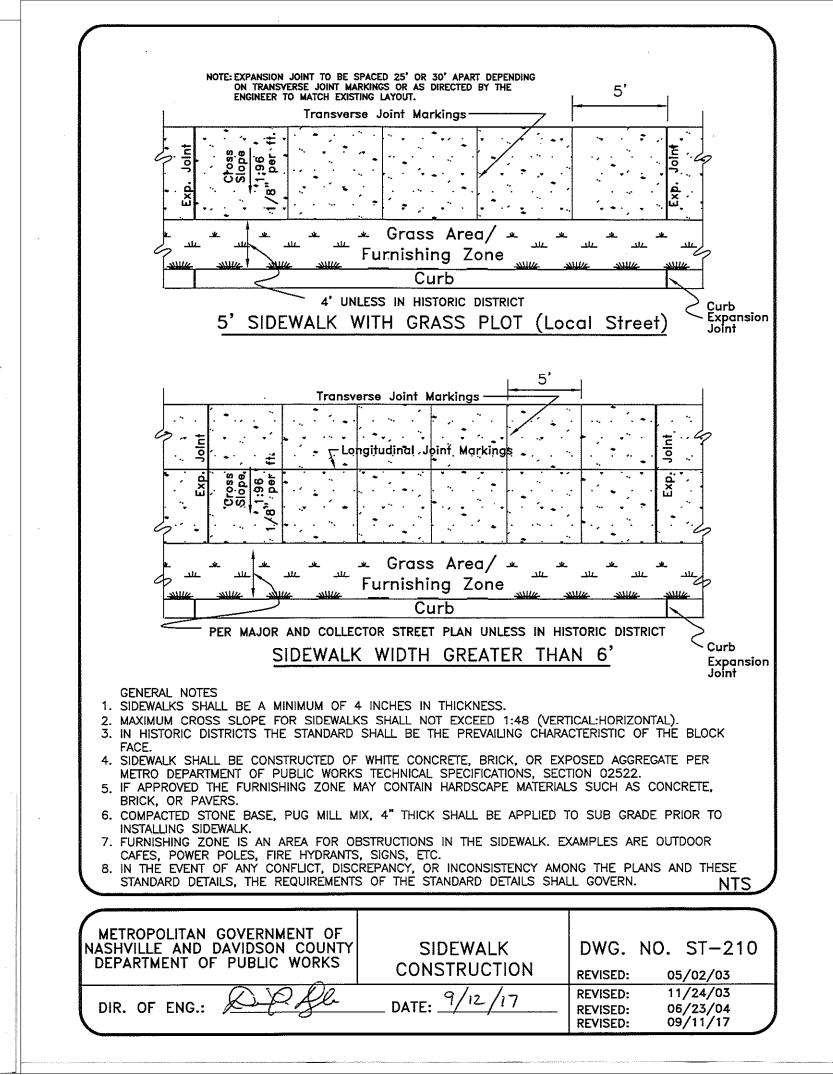
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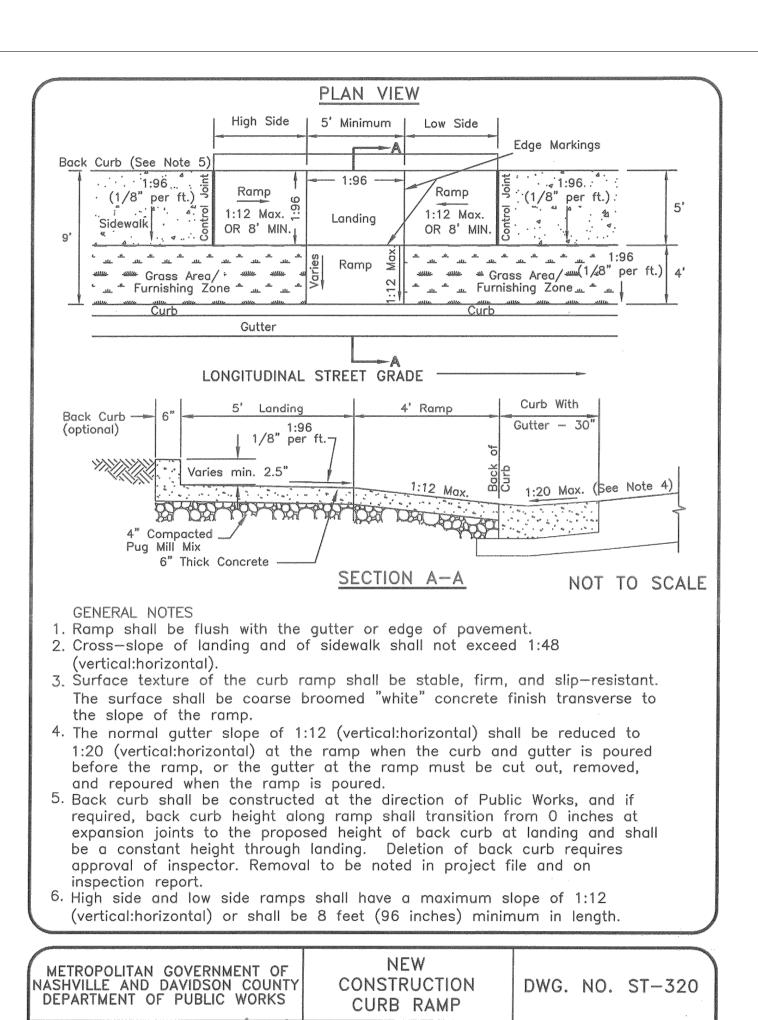
PLANS

FOR REVIEW ONLY








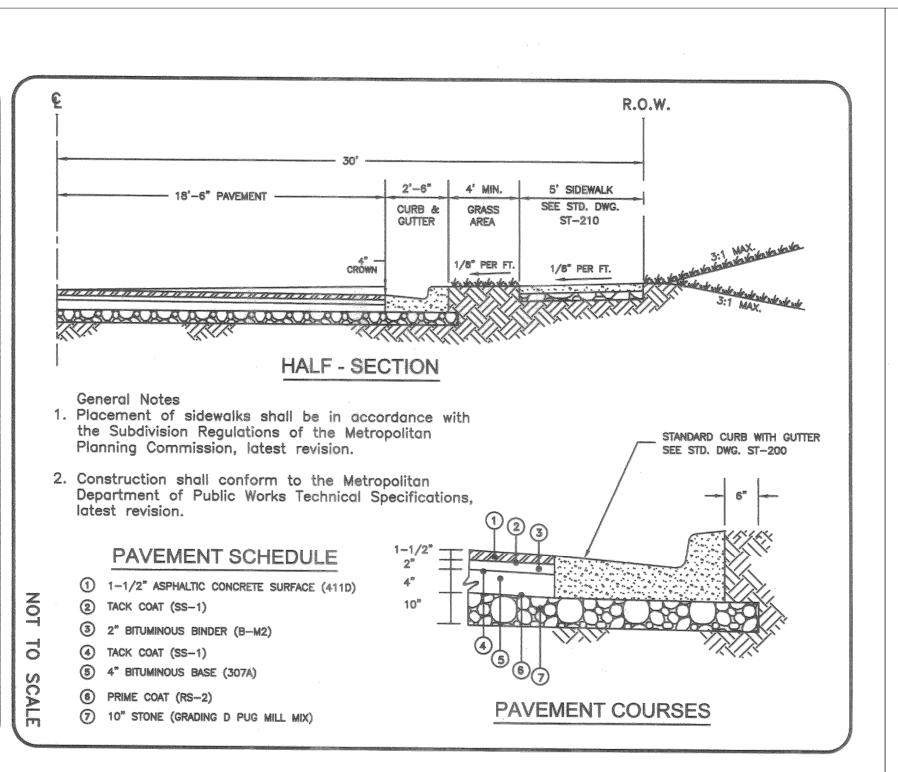


REVISED:

04

01

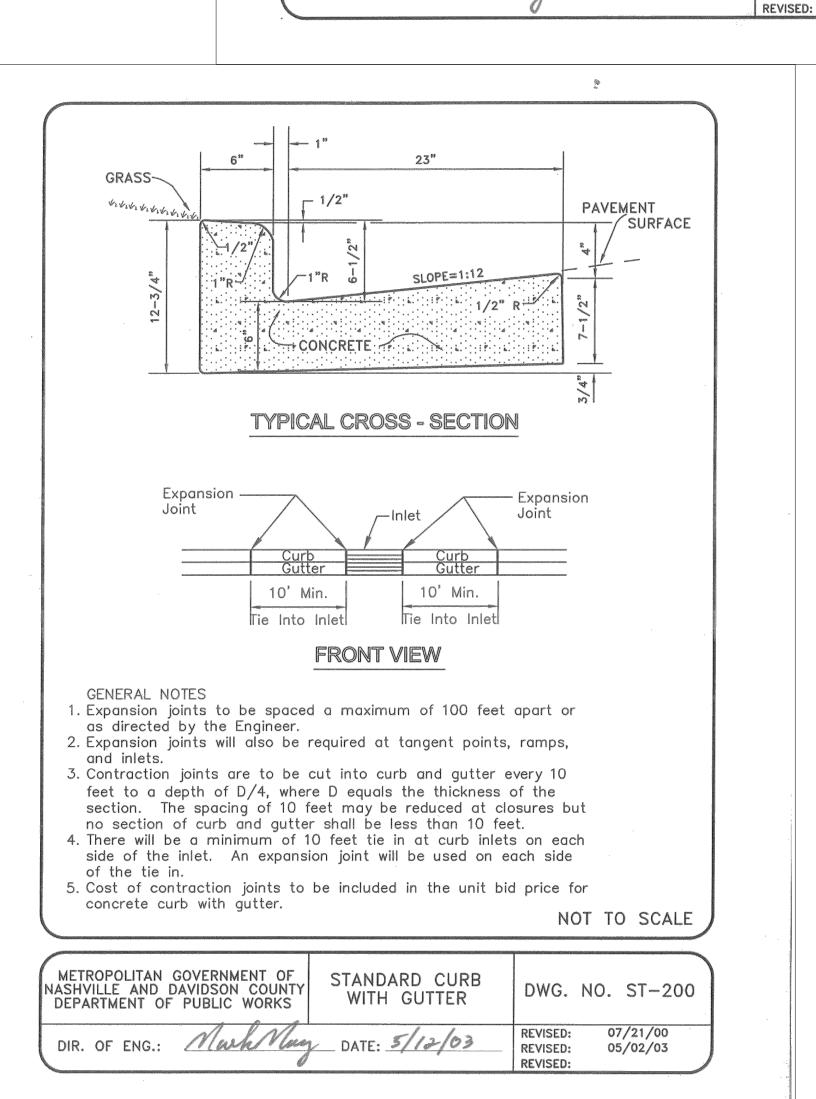

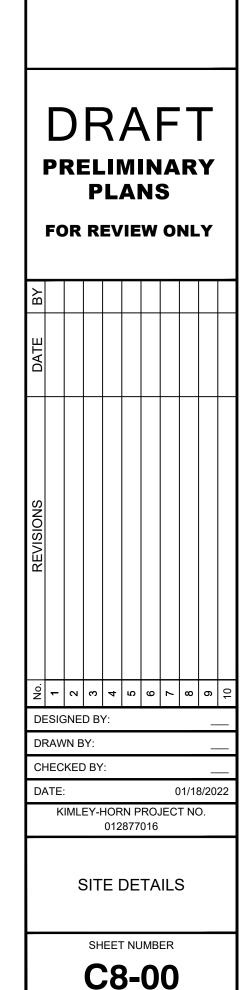

DATE: 5/12/03

07/18/02

05/08/03

REVISED: REVISED:



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SOUTH ELEVATION

TAG	DESCRIPTION	COLOR	MANUFACTURER	TAG	DESCRIPTION	COLOR	MANUFACTURER
AR-1	ASPHALT SHINGLE ROOF	DARK GRAY	REFER TO GN-1 BASIS OF DESIGN	MR-1	42" VINYL RAILING	WHITE	REFER TO GN-1 BASIS OF DESIGN
BR-1	PAINTED QUEEN BRICK VENEER	WHITE	TBD	MR-2	STANDING SEAM METAL ROOF	CHARCOAL	MCELROY OR EQUAL
DR-1	BRICK MORTAR	WHITE	TBD	VW-1	VINYL WINDOW	WHITE	REFER TO GN-1 BASIS OF DESIGN
CP-1	FIBER CEMENT PANEL (4'X10')	WHITE	REFER TO GN-1 BASIS OF DESIGN	VT-1	TOILET / DRYER EXHAUST VENT	MATCH ADJECENT	TBD
CP-2	FIBER CEMENT PANEL (4'X10')	DARK GRAY	ALLURA OR EQ.				
CS-1	FIBER CEMENT LAP SIDING - 6" EXPOSURE (SMOOTH)	DARK GRAY	ALLURA OR EQ.				
CS-2	FIBER CEMENT LAP SIDING - 6" EXPOSURE (SMOOTH)	WHITE	ALLURA OR EQ.				
CT-1	FIBER CEMENT TRIM (SMOOTH)	WHITE	ALLURA OR EQ.				
CT-2	FIBER CEMENT TRIM (SMOOTH)	DARK GRAY	ALLURA OR EQ.				
CT-3	FIBER CEMENT TRIM (SMOOTH)	DARK BRONZE	ALLURA OR EQ.				
DS-1	DOWNSPOUT & GUTTER	MATCH ADJECENT	REFER TO GN-1 BASIS OF DESIGN				
LT-1	LIGTHING FIXTURE	XX	xx				
LT-2	LIGTHING FIXTURE	xx	xx				

LEGEND

NOTES

1. MINIMUM MOUNTING HEIGHT FOR EXTERIOR LIGHTS IS 6' - 8" A.F.F. TO BOTTOM OF THE FIXTURE, TYP.

2. THE QUEEN BRICK SPECIFIED AND DETAILED IN THESE DRAWINGS IS BASED ON THE BRICK INDUSTRY ASSOCIATION STANDARD SIZE OF 2 3/4" WIDE BY 2 3/4" TALL BY 7 5/8" LONG


3. EXHAUST VENTS TO EXIT AT SOFFIT OR BALCONY CEILING WHERE INDICATED WITH KEYNOTE 3

4. BRICK LEDGE - REFER TO DETAIL 1/A5-63 FOR ADDITIONAL INFORMATION


5. METER CENTER - REFER TO SP-01 FOR EXACT LOCATION PER BUILDING

6. LINE DENOTES JOINT BETWEEN FIBER CEMENT PANELS ALL OTHER JOINTS TO BE BEHIND FIBER CEMENT BATTEN TRIM

NOTE: ELEVATIONS ARE REPRESENTATIVE ONLY OF TOWNHOMES FRONTING DODSON CHAPEL ROAD

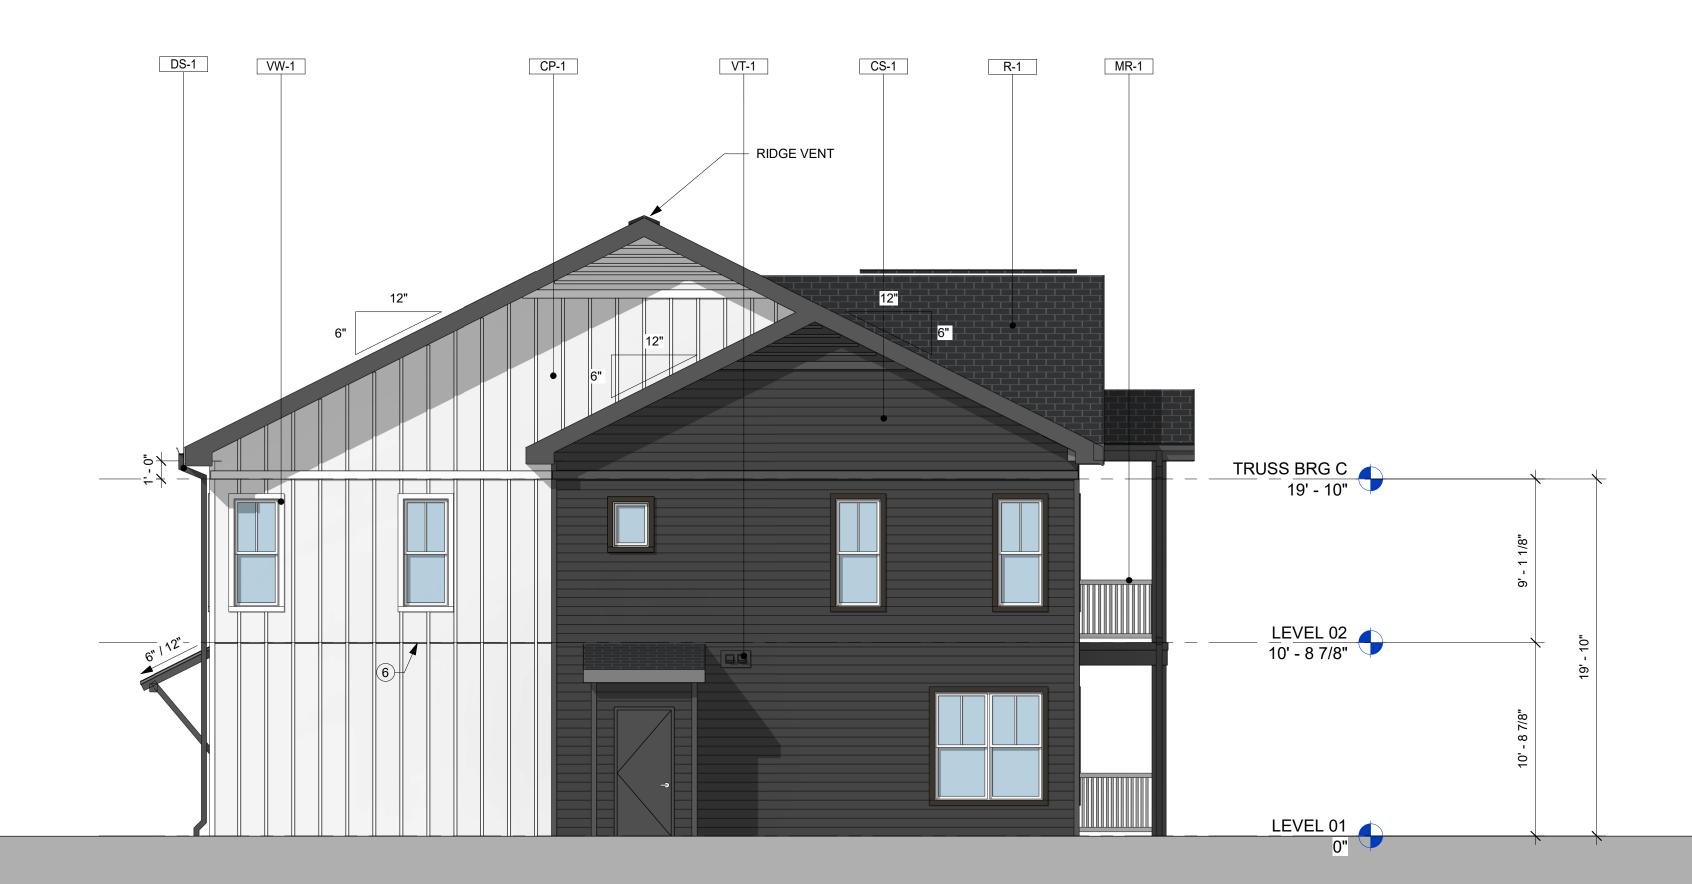



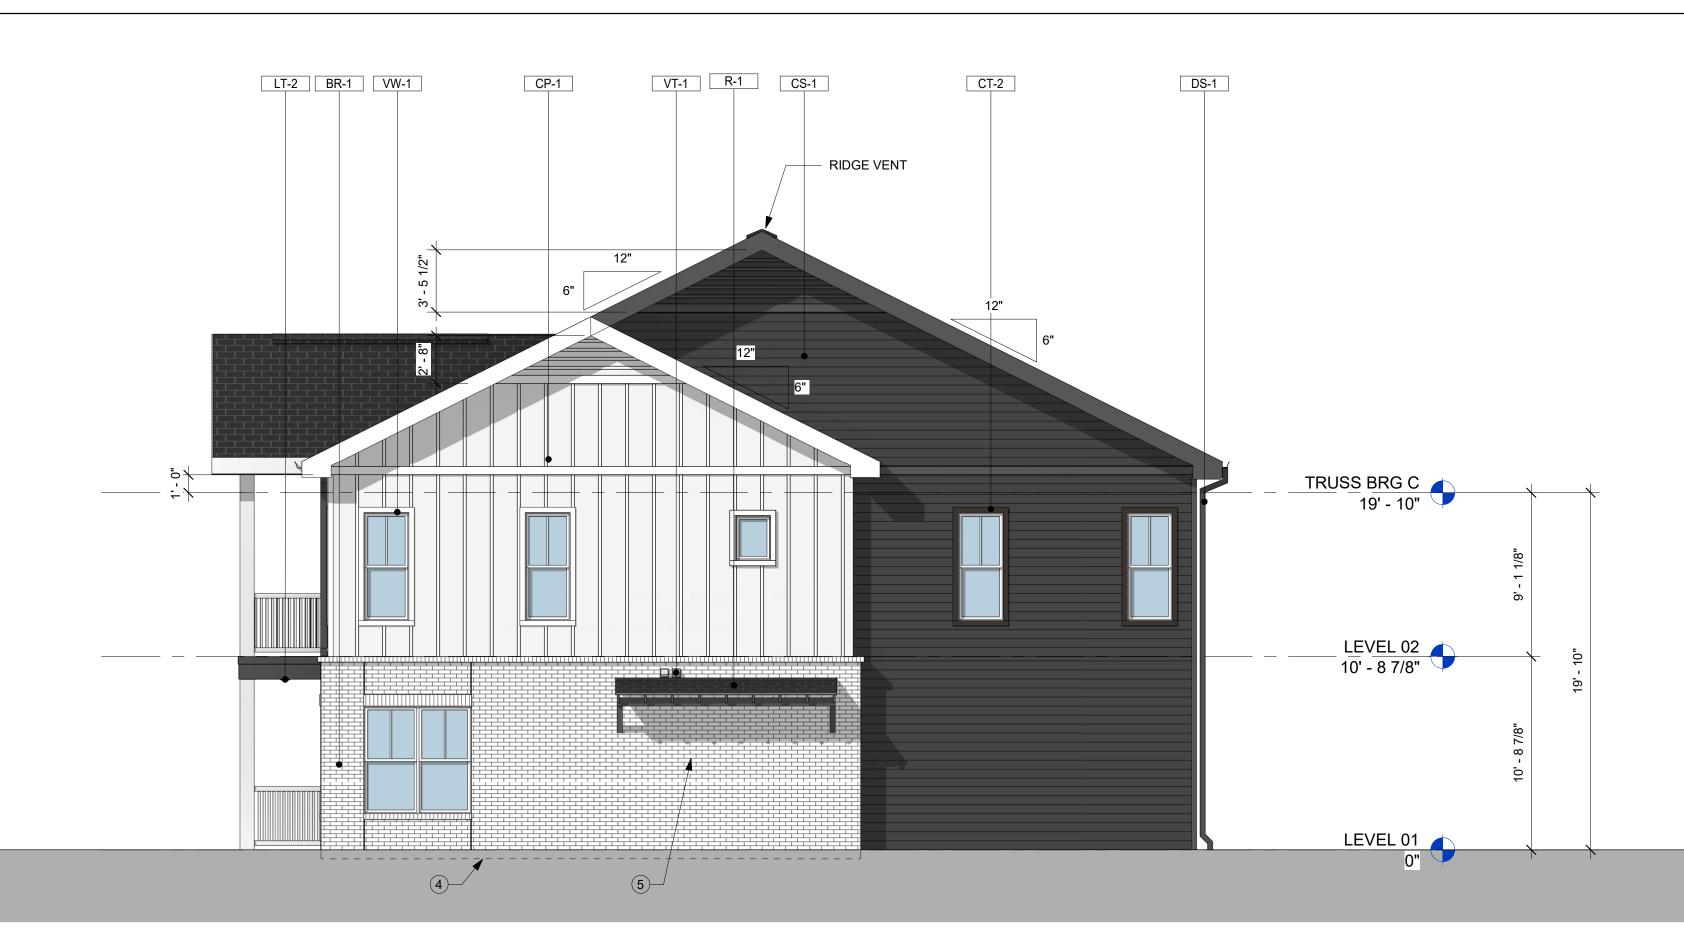

WEST ELEVATION

SCALE: 3/16" = 1'.0"

LE	EGEND						
TAG	DESCRIPTION	COLOR	MANUFACTURER	TAG	DESCRIPTION	COLOR	MANUFACTURER
AR-1	ASPHALT SHINGLE ROOF	DARK GRAY	REFER TO GN-1 BASIS OF DESIGN	MR-1	42" VINYL RAILING	WHITE	REFER TO GN-1 BASIS OF DESIGN
BR-1	PAINTED QUEEN BRICK VENEER	WHITE	TBD	MR-2	STANDING SEAM METAL ROOF	CHARCOAL	MCELROY OR EQUAL
DR-1	BRICK MORTAR	WHITE	TBD	VW-1	VINYL WINDOW	WHITE	REFER TO GN-1 BASIS OF DESIGN
CP-1	FIBER CEMENT PANEL (4'X10')	WHITE	REFER TO GN-1 BASIS OF DESIGN	VT-1	TOILET / DRYER EXHAUST VENT	MATCH ADJECENT	TBD
CP-2	FIBER CEMENT PANEL (4'X10')	DARK GRAY	ALLURA OR EQ.				
CS-1	FIBER CEMENT LAP SIDING - 6" EXPOSURE (SMOOTH)	DARK GRAY	ALLURA OR EQ.				
CS-2	FIBER CEMENT LAP SIDING - 6" EXPOSURE (SMOOTH)	WHITE	ALLURA OR EQ.				
CT-1	FIBER CEMENT TRIM (SMOOTH)	WHITE	ALLURA OR EQ.				
CT-2	FIBER CEMENT TRIM (SMOOTH)	DARK GRAY	ALLURA OR EQ.				
CT-3	FIBER CEMENT TRIM (SMOOTH)	DARK BRONZE	ALLURA OR EQ.				
DS-1	DOWNSPOUT & GUTTER	MATCH ADJECENT	REFER TO GN-1 BASIS OF DESIGN				
LT-1	LIGTHING FIXTURE	XX	XX				
LT-2	LIGTHING FIXTURE	XX	xx				

NOTES

1. MINIMUM MOUNTING HEIGHT FOR EXTERIOR LIGHTS IS 6' - 8" A.F.F. TO BOTTOM OF THE FIXTURE, TYP.

2. THE QUEEN BRICK SPECIFIED AND DETAILED IN THESE DRAWINGS IS BASED ON THE BRICK INDUSTRY ASSOCIATION STANDARD SIZE OF 2 3/4" WIDE BY 2 3/4" TALL BY 7 5/8" LONG

3. EXHAUST VENTS TO EXIT AT SOFFIT OR BALCONY CEILING WHERE INDICATED WITH KEYNOTE 3

4. BRICK LEDGE - REFER TO DETAIL 1/A5-63 FOR ADDITIONAL INFORMATION

5. METER CENTER - REFER TO SP-01 FOR EXACT LOCATION PER BUILDING

6. LINE DENOTES JOINT BETWEEN FIBER CEMENT PANELS ALL OTHER JOINTS TO BE BEHIND FIBER CEMENT BATTEN TRI

NOTE: ELEVATIONS ARE REPRESENTATIVE ONLY OF TOWNHOMES FRONTING DODSON CHAPEL ROAD